


MEZZANINE LEVEL 2 FLOOR FRAMING PLAN
 Scale: 1/8" = 1'-0"



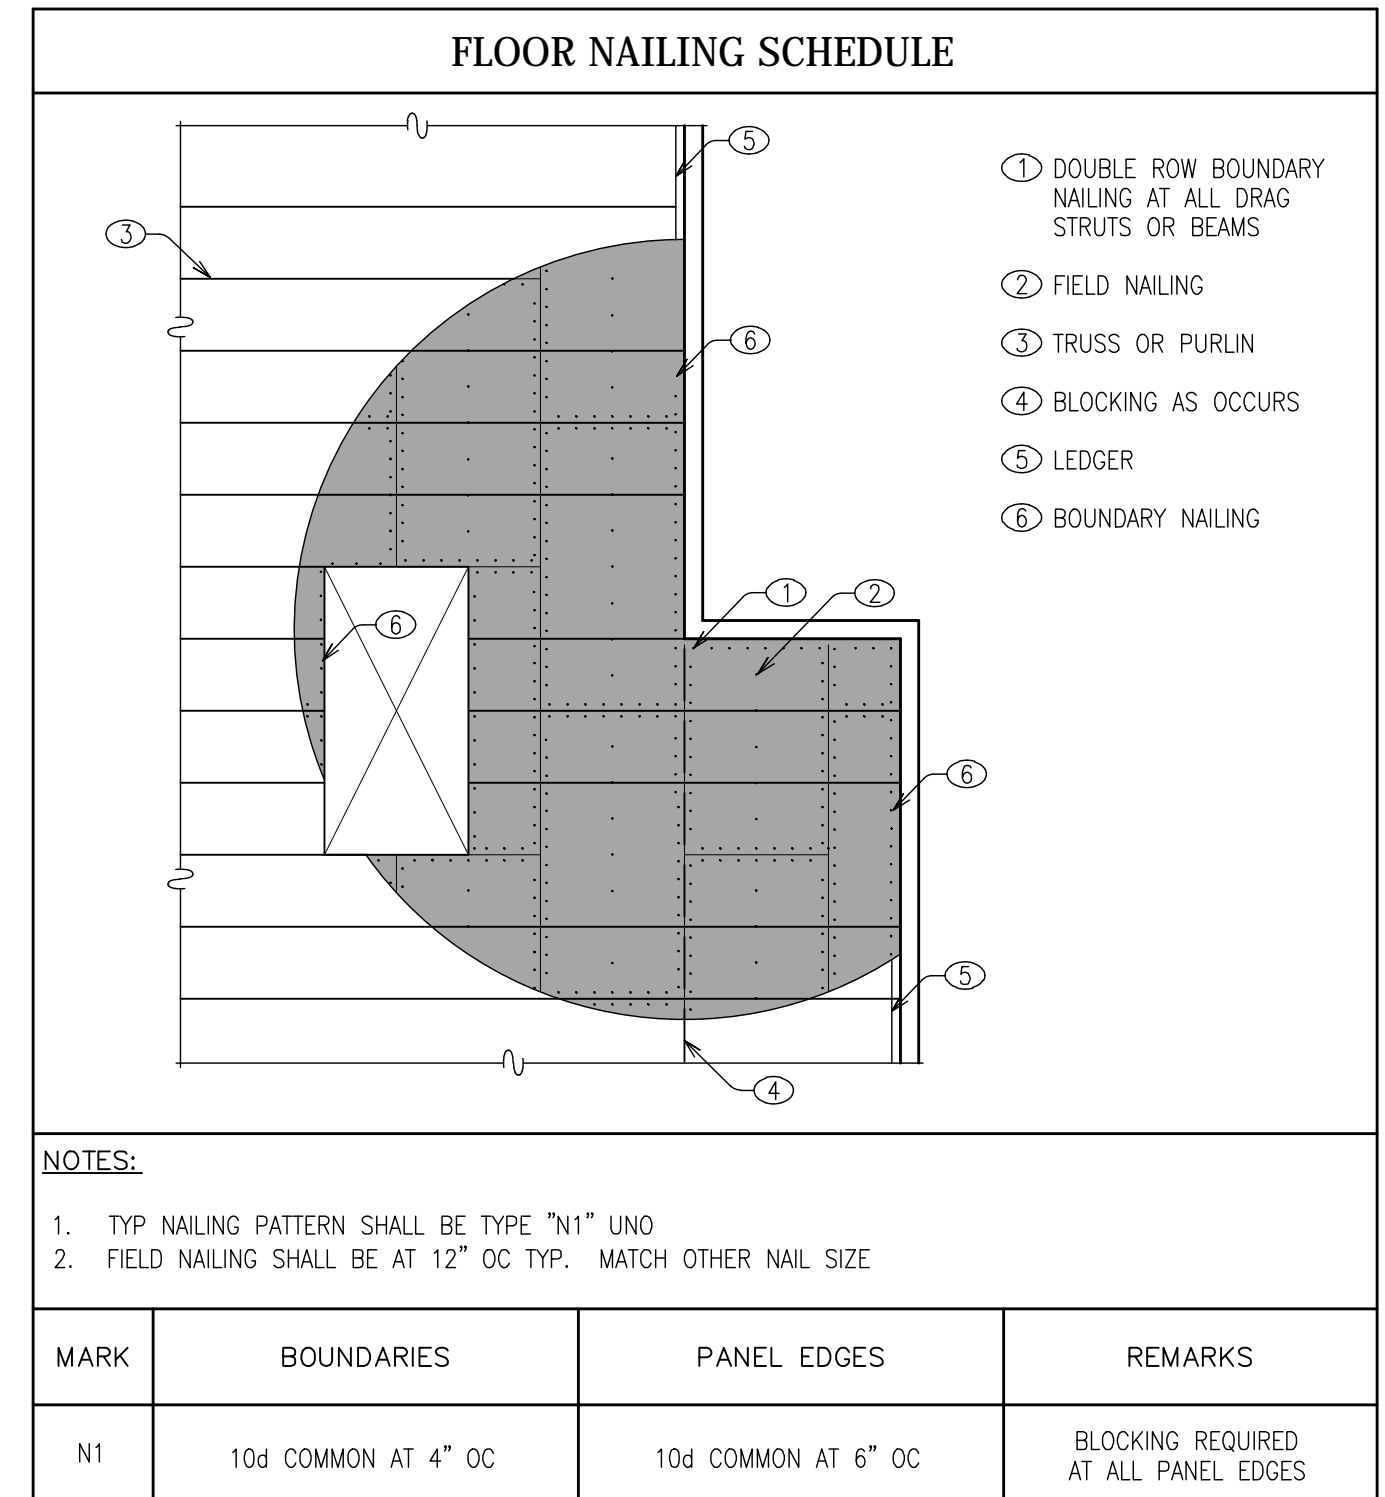

NOTES:

- TYP NAILING PATTERN SHALL BE TYPE "N1" UNO
- FIELD NAILING SHALL BE AT 12" OC TYP. MATCH OTHER NAIL SIZE

| MARK | BOUNDARIES | PANEL EDGES | REMARKS |
|------|---------------------|---------------------|--------------------------------------|
| N1 | 10d COMMON AT 4" OC | 10d COMMON AT 6" OC | BLOCKING REQUIRED AT ALL PANEL EDGES |

- FLOOR FRAMING NOTES**
- FLOOR DECKING TO BE: 3/4" C-D PLYWOOD PER GSN. SECURE WITH #10 RINGSHANK NAILS AT 4" OC EDGES AND BOUNDARY AND 12" OC IN FIELD.
 - "D" = INDICATES DRAG LOAD (TENSION OR COMPRESSION) DUE TO WIND OR SEISMIC. MFR SHALL DESIGN FOR INDICATED LOAD IN APPROPRIATE LOAD COMBO. TRUSS AND DRAG LOAD SHALL BE SPECIFICALLY LOCATED WHERE SHOWN ON PLAN AND DETAIL TO ALLOW LOAD TRANSFER TO ADJACENT DRAG TRUSS, WALL OR STRAP.



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LICENSE STAMP

TO THE BEST OF MY KNOWLEDGE THESE PLANS ARE IN ACCORDANCE WITH THE LATEST EDITION OF THE 2007 FLORIDA BUILDING CODE WITH 2009 SUPPLEMENTS

REVISIONS

| NO. | DATE | BY | DESCRIPTION |
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PROJECT
 2007 FBC WIND DESIGN UPDATE FOR:
DAYTONA BEACH PIER
MAIN STREET
 DAYTONA BEACH, FLORIDA

DRAWING TITLE
 MEZZANINE LEVEL 2
 FLOOR FRAMING PLAN

| | |
|--------------|----------|
| JOB NO. | 10-010 |
| SCALE | AS NOTED |
| DRAWN | JJB |
| CHECKED | JPS |
| DATE | 7/1/10 |
| SHEET NUMBER | |

S2.2