


**MEZZANINE LEVEL 1 FLOOR FRAMING PLAN**  
 Scale: 1/8" = 1'-0"  

**FLOOR FRAMING NOTES**

- FLOOR DECKING TO BE: 3/4" C-D PLYWOOD PER GSN. SECURE WITH #10 RINGSHANK NAILS AT 4" OC EDGES AND BOUNDARY AND 12" OC IN FIELD.
- "D" = INDICATES DRAG LOAD (TENSION OR COMPRESSION) DUE TO WIND OR SEISMIC. MFR SHALL DESIGN FOR INDICATED LOAD IN APPROPRIATE LOAD COMBO. TRUSS AND DRAG LOAD SHALL BE SPECIFICALLY LOCATED WHERE SHOWN ON PLAN AND DETAIL TO ALLOW LOAD TRANSFER TO ADJACENT DRAG TRUSS, WALL OR STRAP.

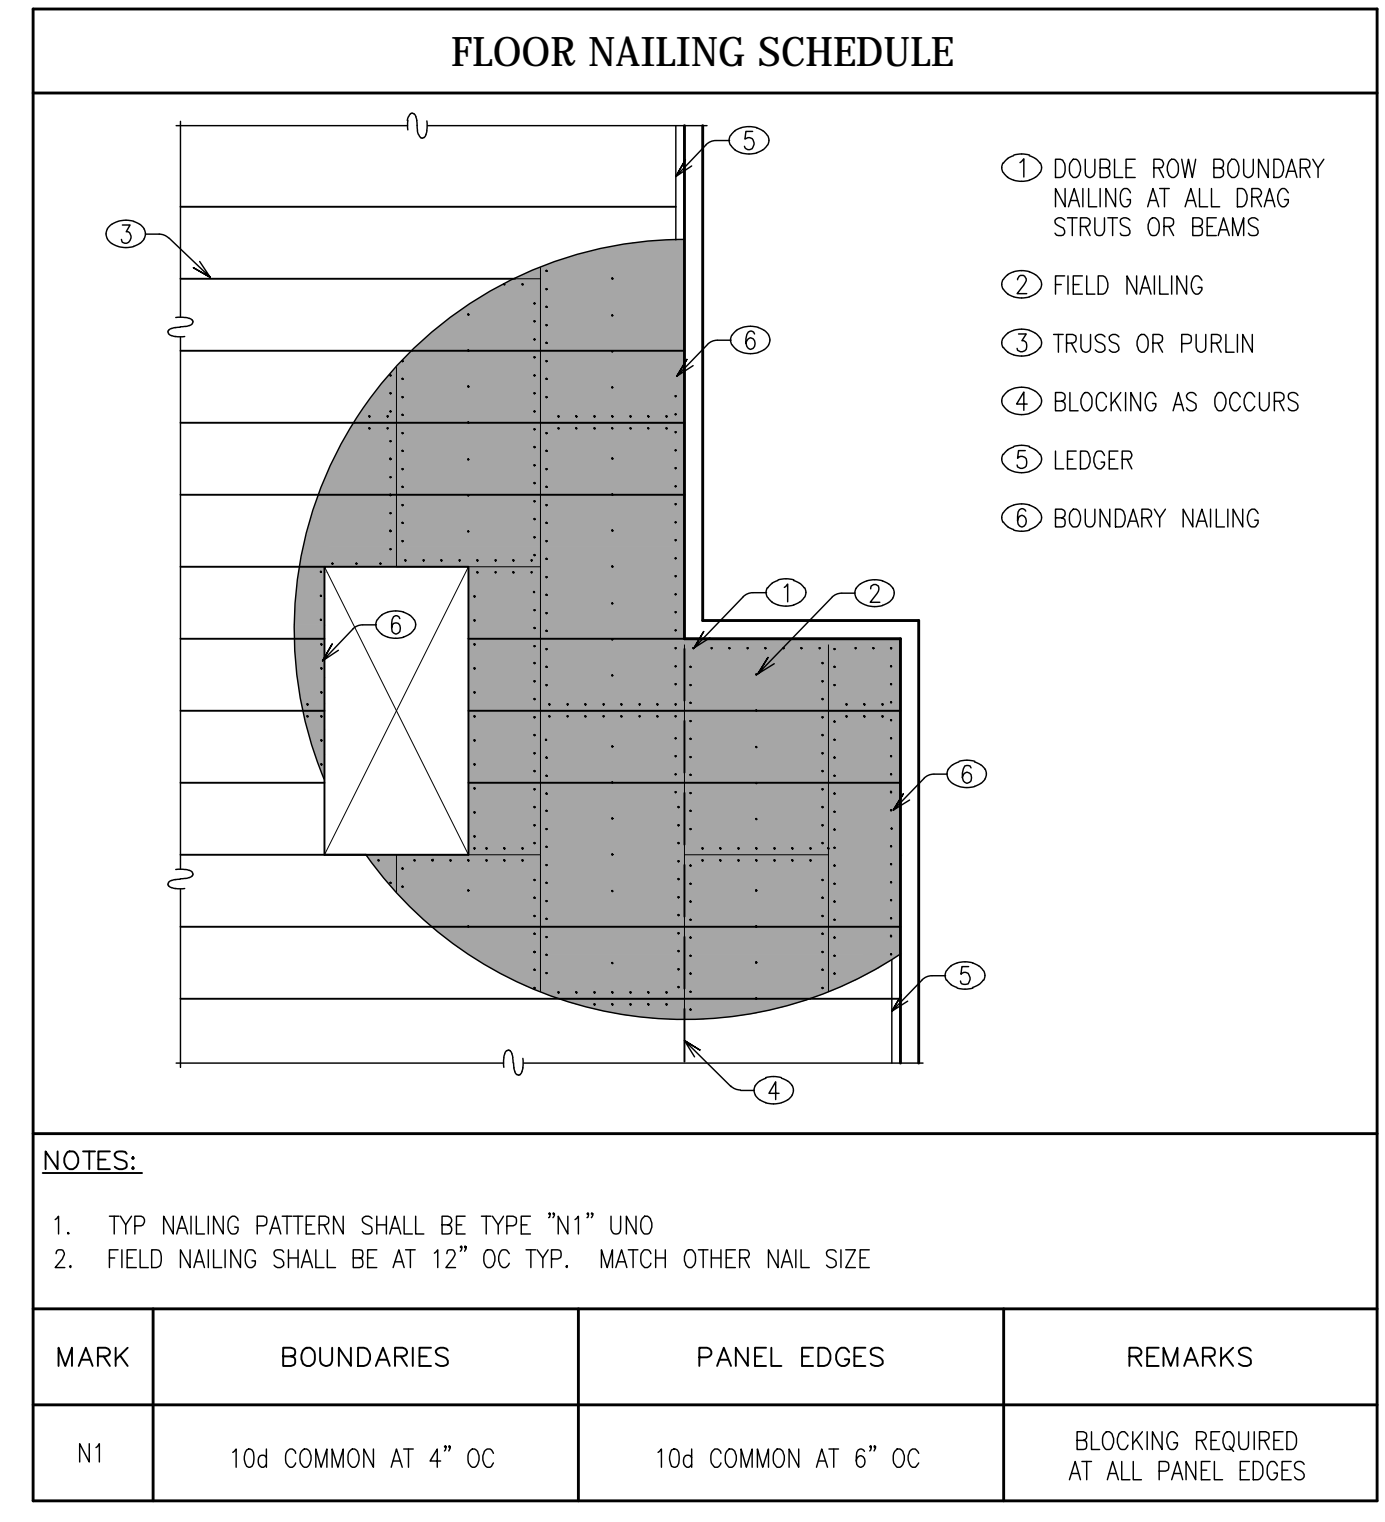

**STRUCTURAL ENGINEERS**  
 400 S. Atlantic Ave., Suite 106  
 Ormond Beach, FL 32176  
 Office: (386) 672-1214  
 Fax: (386) 672-1421  
 JOHN SIMKO  
 STRUCTURAL ENGINEER  
 FLORIDA 30122  
 msstructural@cfl.rr.com

LICENSE STAMP

TO THE BEST OF MY KNOWLEDGE THESE PLANS ARE IN ACCORDANCE WITH THE LATEST EDITION OF THE 2007 FLORIDA BUILDING CODE WITH 2009 SUPPLEMENTS

REVISIONS

NO.	DATE	BY	DESCRIPTION

PROJECT  
 2007 FBC WIND DESIGN UPDATE FOR:  
**DAYTONA BEACH PIER**  
**MAIN STREET**  
 DAYTONA BEACH, FLORIDA

DRAWING TITLE  
 MEZZANINE LEVEL 1  
 FLOOR FRAMING PLAN

JOB NO.	10-010
SCALE	AS NOTED
DRAWN	JJB
CHECKED	JPS
DATE	7/1/10

SHEET NUMBER  
**S2.1**